

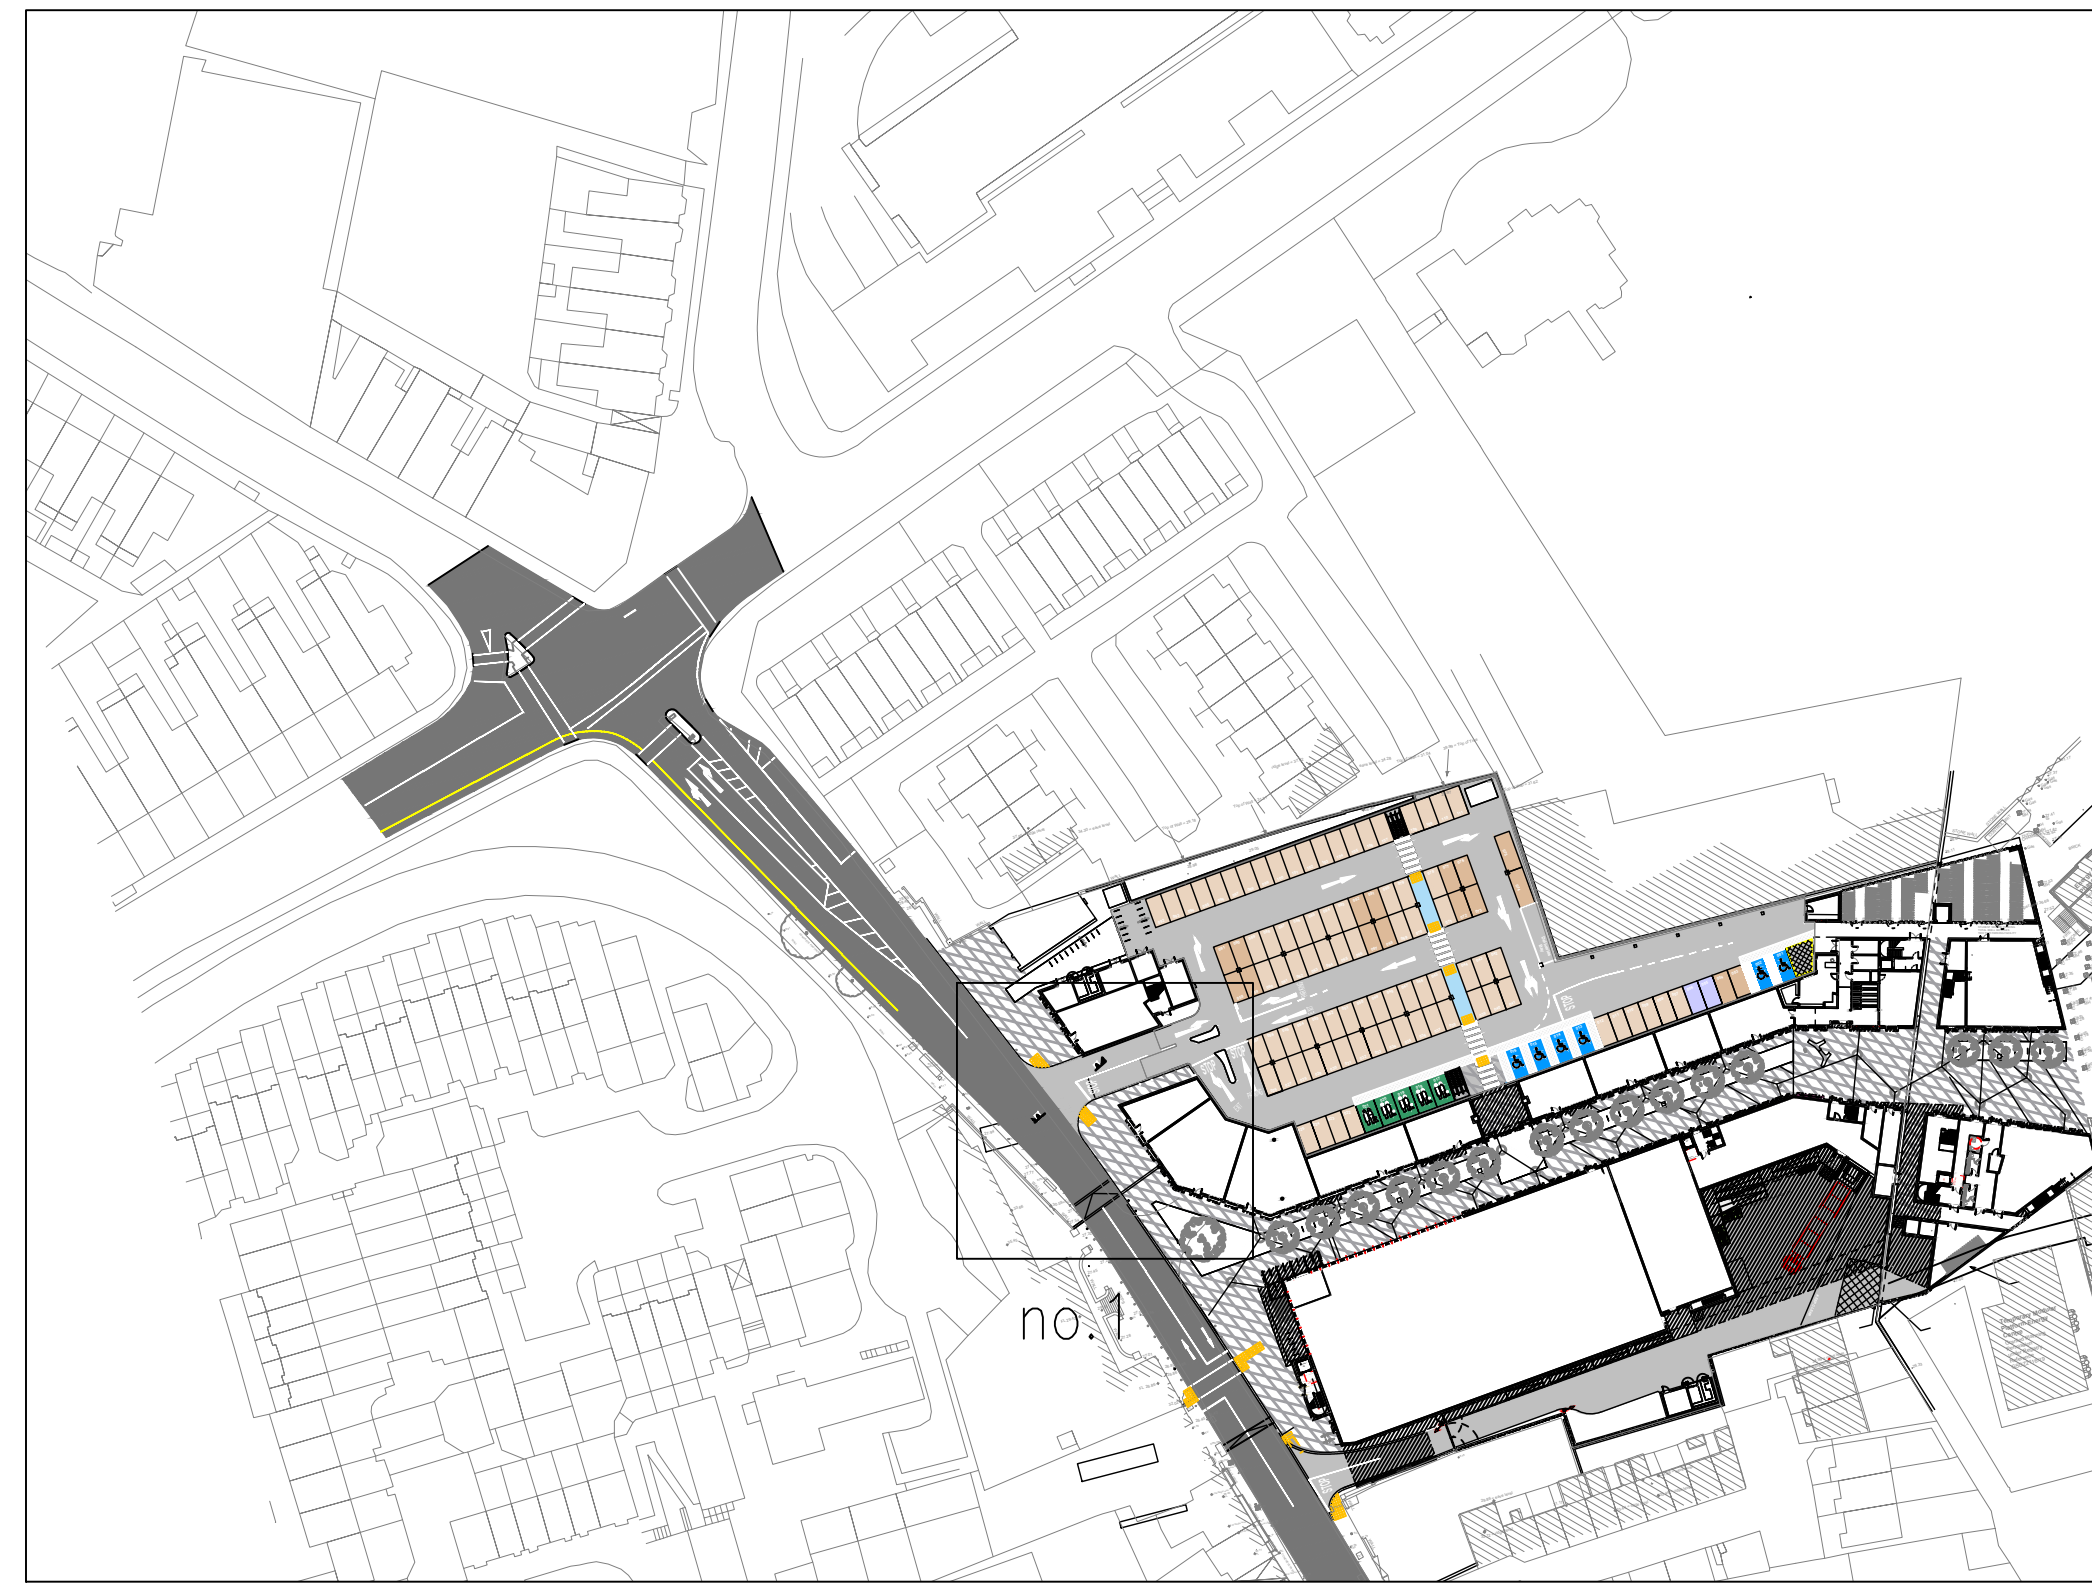


No. 1 – SITE ENTRANCE

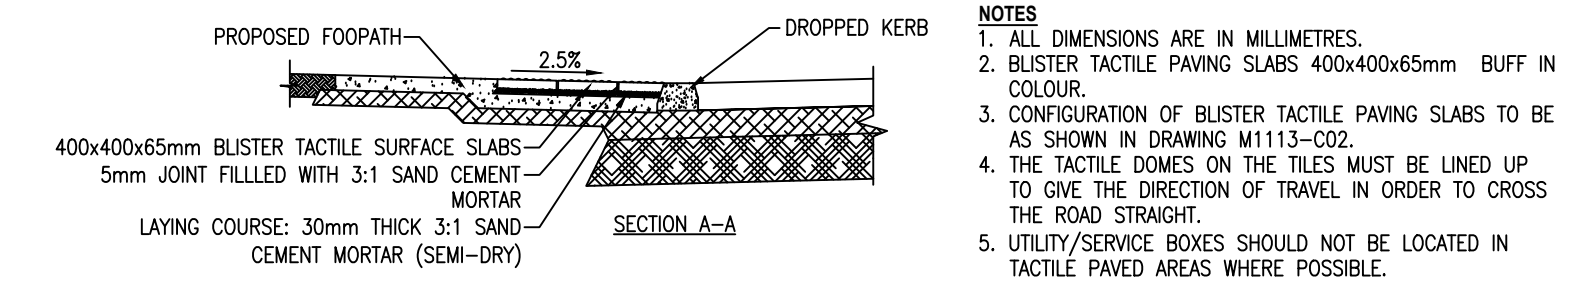


SITE PLAN

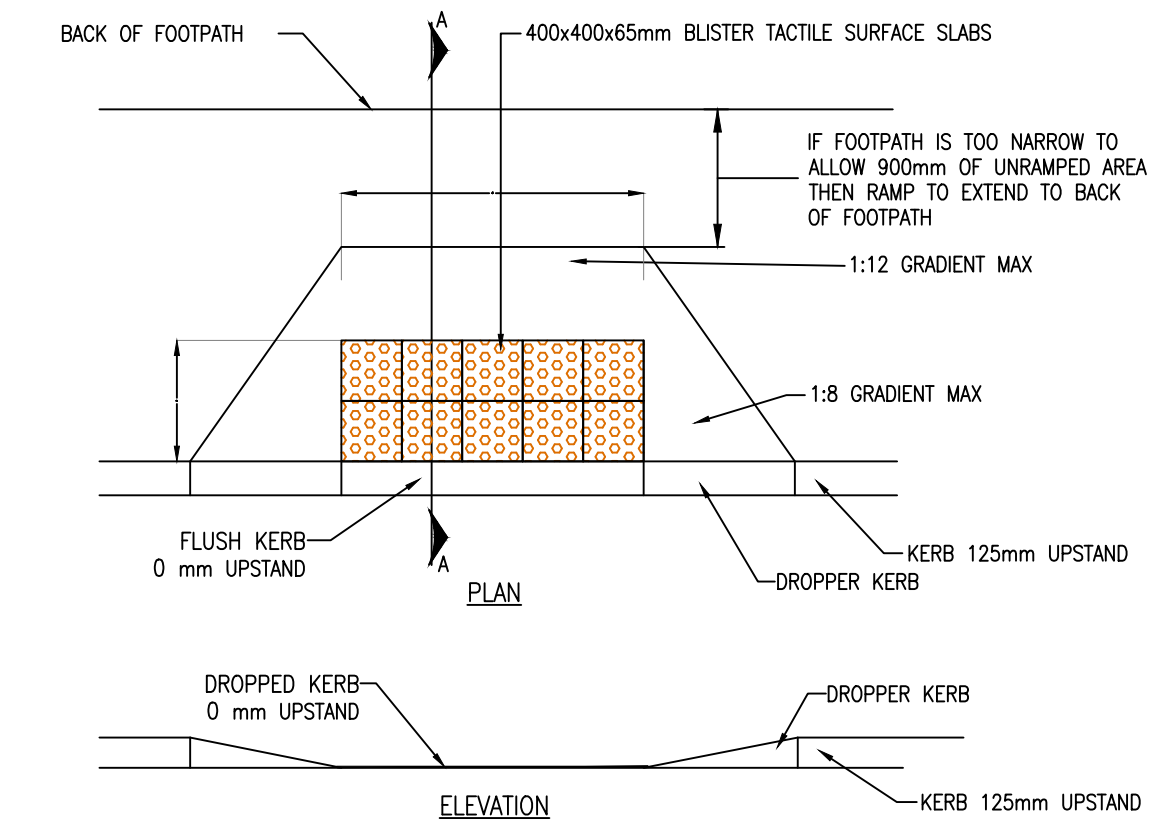


PEDESTRIAN CROSSING
SCALE 1:50
UNCONTROLLED PEDESTRIAN CROSSING

- NOTES**
1. ALL DIMENSIONS ARE IN MILLIMETRES.
 2. BLISTER TACTILE PAVING SLABS 400x400x65mm BUFF IN COLOUR.
 3. CONFIGURATION OF BLISTER TACTILE PAVING SLABS TO BE AS SHOWN IN DRAWING M1113-C022.
 4. THE TACTILE DOMES ON THE TILES MUST BE LINED UP TO GIVE THE DIRECTION OF TRAVEL IN ORDER TO CROSS THE ROAD STRAIGHT.
 5. UTILITY/SERVICE BOXES SHOULD NOT BE LOCATED IN TACTILE PAVED AREAS WHERE POSSIBLE.

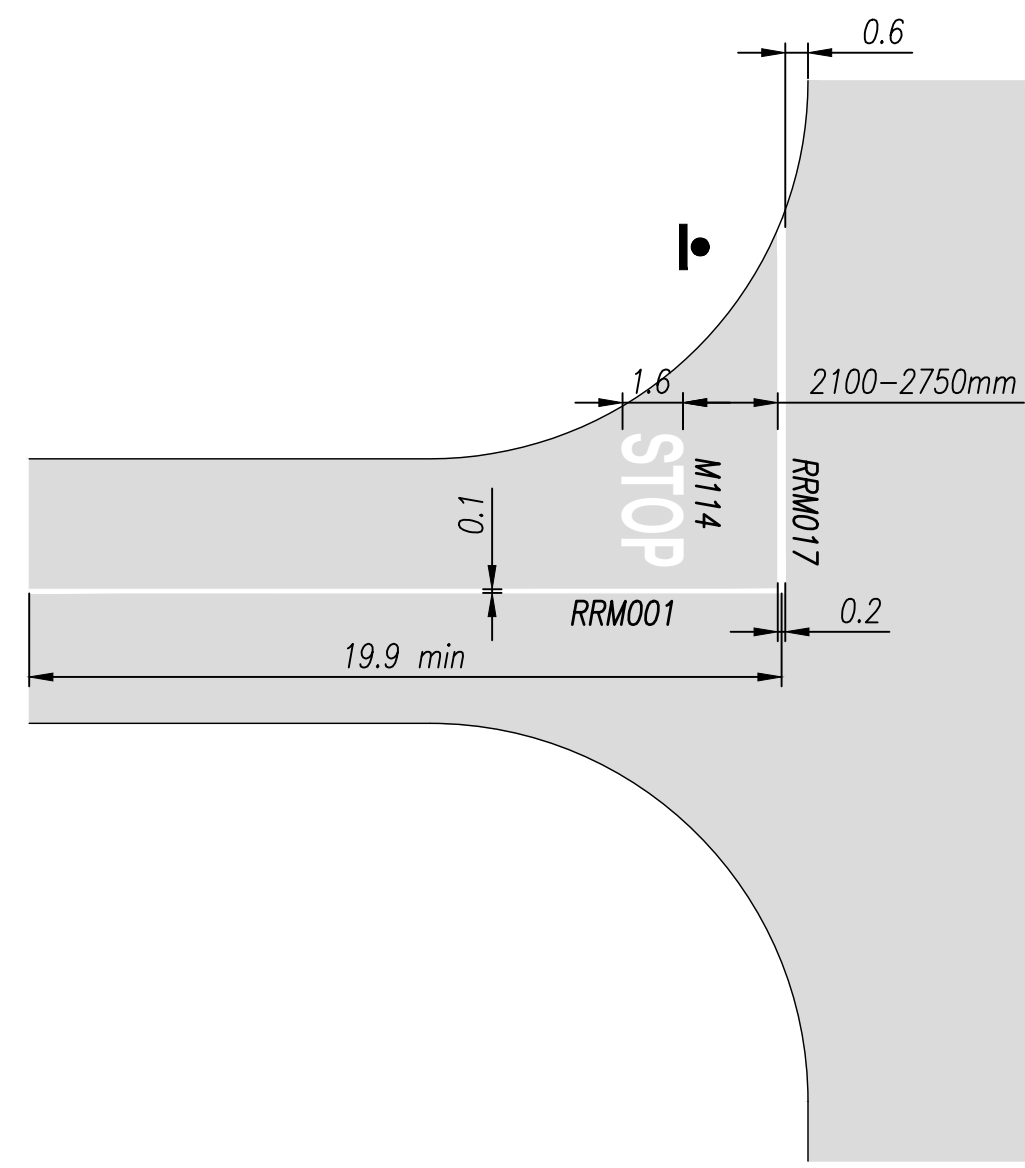


TYPICAL PRIORITY CONTROLLED JUNCTION
NTS

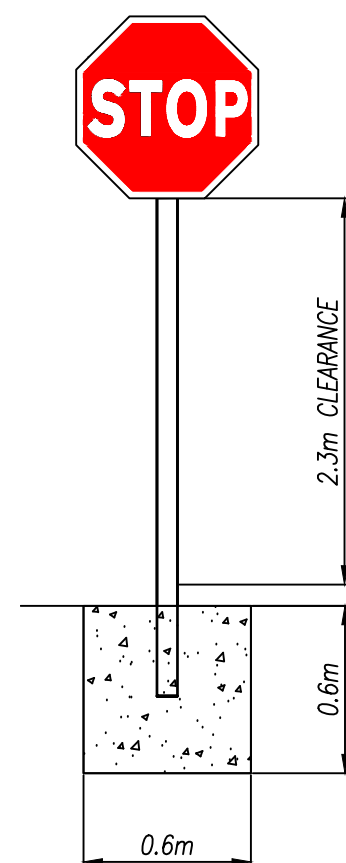


POLE DETAIL
NTS

FOOTPATH CONSTRUCTION:
100MM CONCRETE ON
MIN 150MM GRANULAR FILL TO CLAUSE 808
GRANULAR MATERIAL (COMPACTED)


ROAD CONSTRUCTION:
50MM CLOSED GRADED ASPHALT CONCRETE SURFACE TO CLAUSE 912 ON
80MM ASPHALT CONCRETE BASE TO CLAUSE 906 ON
300MM TO 550MM SUB-BASE - CLAUSE 808 GRANULAR MATERIAL NOTE: THE
DEPTH OF THIS SUB-BASE IS DEPENDENT UPON THE CBR OF THE FORMATION.
SEE TABLE 1.

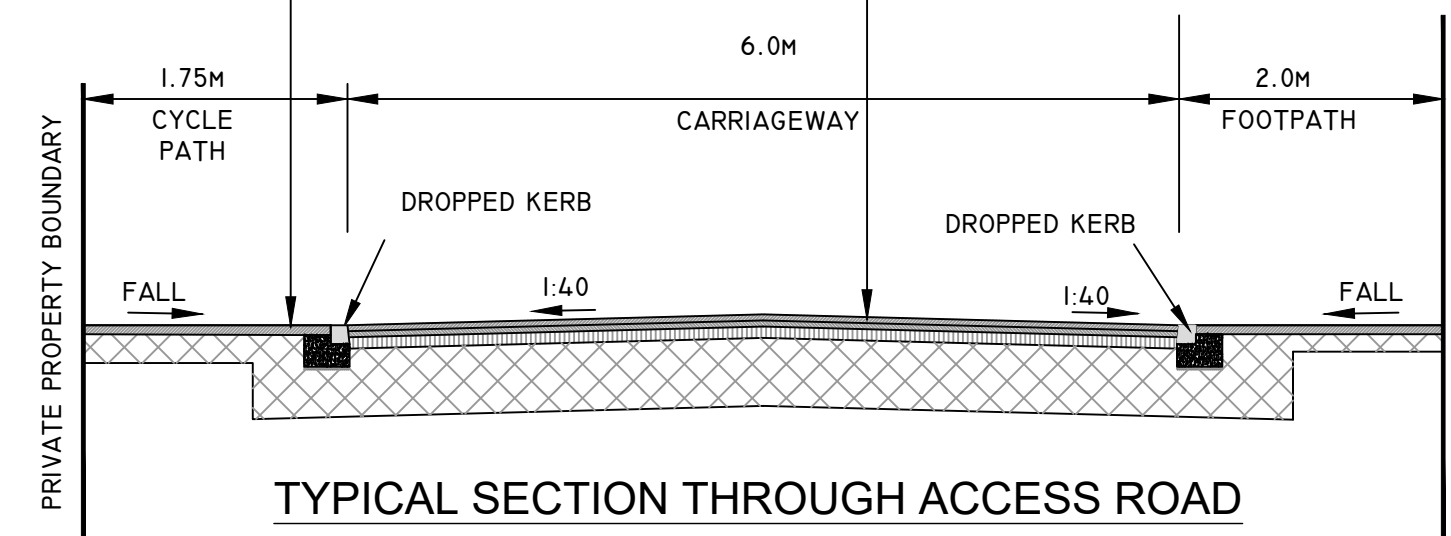

TYPICAL SECTION THROUGH ACCESS ROAD
SCALE 1:50

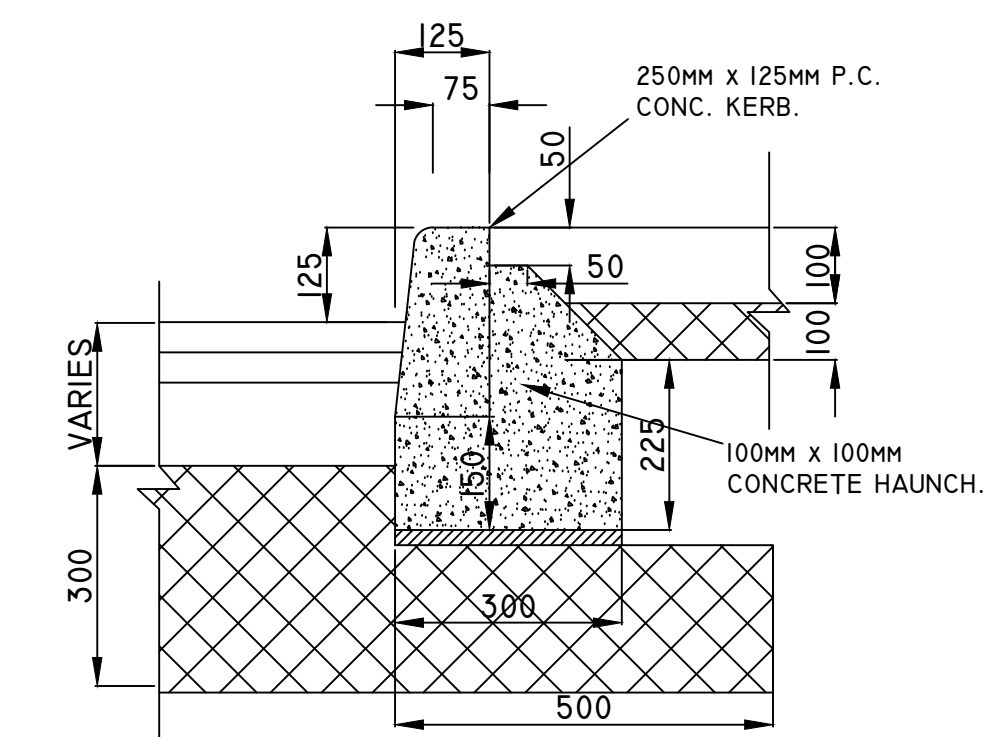

TYPICAL PRECAST KERB DETAIL
SCALE 1:10

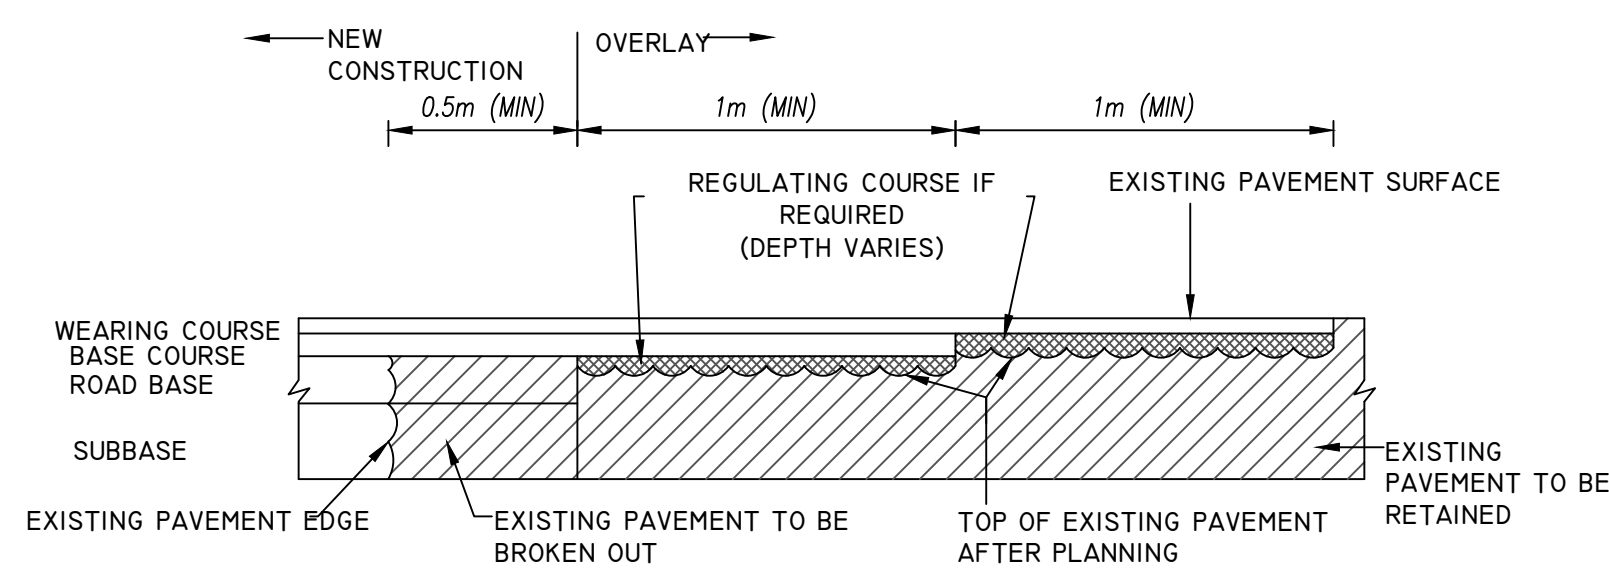

TRANSVERSE JOINT BETWEEN NEW
CONSTRUCTION AND EXISTING ROAD SECTION A-A
SCALE 1:20

GENERAL NOTES

1. DO NOT SCALE THIS DRAWING. WORK ONLY TO FIGURED DIMENSIONS.
2. FOR ALL RELEVANT NOTES, REFER TO STRUCTURAL AND CIVIL ENGINEERING PERFORMANCE SPECIFICATION.
3. ANY DISCREPANCIES ARE TO BE REPORTED TO PINNACLE CONSULTING ENGINEERS IMMEDIATELY.
4. THIS DRAWING IS TO BE READ IN CONJUNCTION WITH ALL OTHER RELEVANT ENGINEERS, ARCHITECTS AND SUB-CONTRACTORS DRAWINGS AND DETAILS.



REV	DESCRIPTION	BY	CHK	DATE
P07	ISSUED FOR PLANNING	RK	JM	26/02/21
P06	RSA UPDATE	RK	RK	18/10/21
P05	STOP LINE MOVED	RK	RK	04/10/21
P04	PARKING UPDATED	RK	RK	12/05/20
P03	CLIENT UPDATED	RK	RK	07/05/20
P02	CLIENT UPDATED	RK	RK	03/04/20

CLIENT
PARK SHOPPING CENTRE LIMITED

PROJECT
PROPOSED MIXED USE DEVELOPMENT AT JAMESON GATE

DRAWING TITLE
ROAD MARKINGS, SIGNAGE LAYOUT & ROAD CONSTRUCTION DETAILS

PINNACLE CONSULTING ENGINEERS

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WELWYN GARDEN CITY | NORWICH | LONDON | THE HAGUE

DRAWING STATUS			
PLANNING			
SCALE @ A1	DATE	DRAWN BY	CHECKED
AS SHOWN	MAR '20	RK	JM
DRG NO.	REVISION		
PIN-ZZ-ZZ-DR-D-120-S2	P07		

TABLE 1

C.B.R. SUB-GRADE (%)	BELOW 2	2	3	4 or More
THICKNESS OF SUB-BASE (mm)	625	475	350	300
SUB BASE + CAPPING LAYER COMPRISING				
SUB-BASE THICKNESS (mm)	150	150		
CAPPING LAYER THICKNESS (mm)	600	350		